

⑦ DEDUCT LIST #1

CONSULTANTS:
ARCHITECTURE/
INTERIOR DESIGN/
LABORATORY PLANNING/
ENVIRONMENTAL ASSESSMENT:

STRUCTURAL:

HDR Architecture, Inc.
560 Mission Street
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CIVIL/SURVEYOR:
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Sunnyvale, CA 94085

GEOTECHNICAL/
ENVIRONMENTAL SERV

LANDSCAPE:
Merrill Morris Partners
249 Front Street
San Francisco, CA 941

HISTORICAL
ARCHITECTURE:

FIRE PROTECTION:
The Fire Consultants Inc.
1276 Durant
Walnut Creek, CA 94596

COST ESTIMATING:

	CON
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CONSULTANT:

ARC
H

ARCHITECTS/

ENGINEER

RS:

VEN J. RIOJAS
No. C-26508
8/31/2011

Drawing Title
ENLA

Approved: Pro

CHARGED SECTION

ON/ FLOOR PPLAN - STAIR 2

Project Title	VM
Location	

San Francisco VA Medical Center
150 Clement Street


Medical Center
San Francisco, CA

Project Number	662-10
Building Number	17
Drawing number	94121

608

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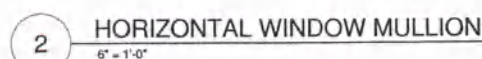
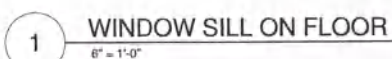
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
7 CONCRETE WALL WINDOW HEAD
6" = 1'-0"

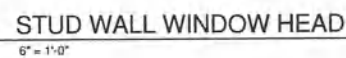


4 CONC WALL WINDOW SILL
6" = 1'-0"



Office of
Construction
and Facilities
Management

 Department of
Veterans Affairs


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NOTES:

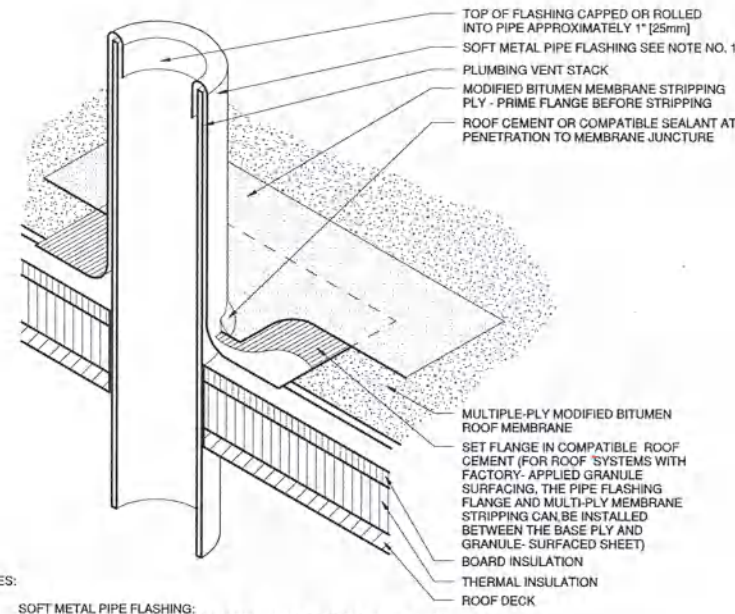
- SOFT METAL PIPE FLASHING: SHEET LEAD: MINIMUM OF 2 1/2 LB. PER SQUARE FOOT (12 kg/m²) OR SHEET COPPER: MINIMUM 16 OZ. (5 kg/m²) IF USING COPPER FLASHING OVER AN IRON OR STEEL PIPE, INSERT A SEPARATOR SHEET (E.G., ASPHALT-SATURATED ROOFING FELT), WRAPPED AROUND PIPE, TO SEPARATE THE COPPER FLASHING FROM DIRECT CONTACT WITH PIPE, TO REDUCE GALVANIC ACTION. VENT STACKS AND OTHER PIPES SHOULD HAVE A MINIMUM OF 12 INCHES (300 mm) OF CLEARANCE ON ALL SIDES FROM WALLS, CURBS, AND OTHER PROJECTIONS TO FACILITATE PROPER FLASHING. (SEE TABLE 4.)

7 PLUMBING VENT 3' x 1'-0"




NOTE: SET ENDS OF PARAPET COPING IN BED OF MASTIC & USE 2 STRIPS OF BUTYL TAPE AT EA. END OF COPING CAP, THEN APPLY SEALANT AT EDGE OF CAP.

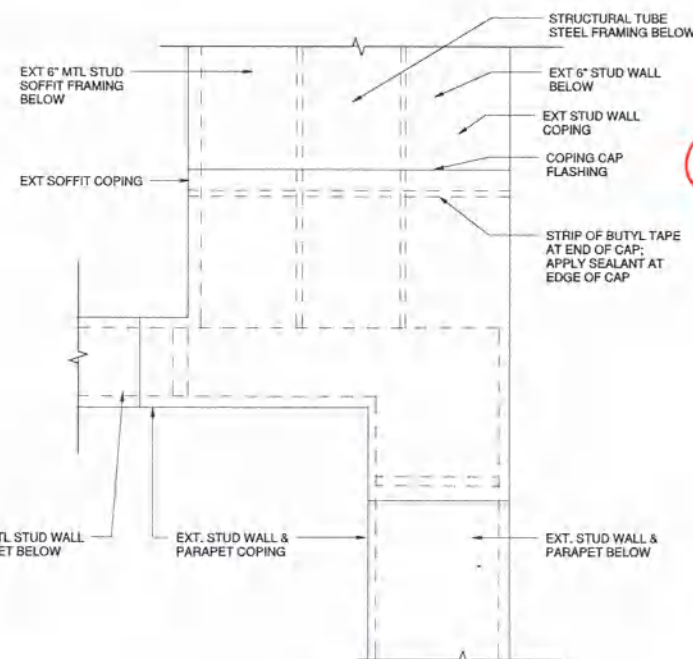
4 PARAPET COPING CAP 1 1/2' x 1'-0"

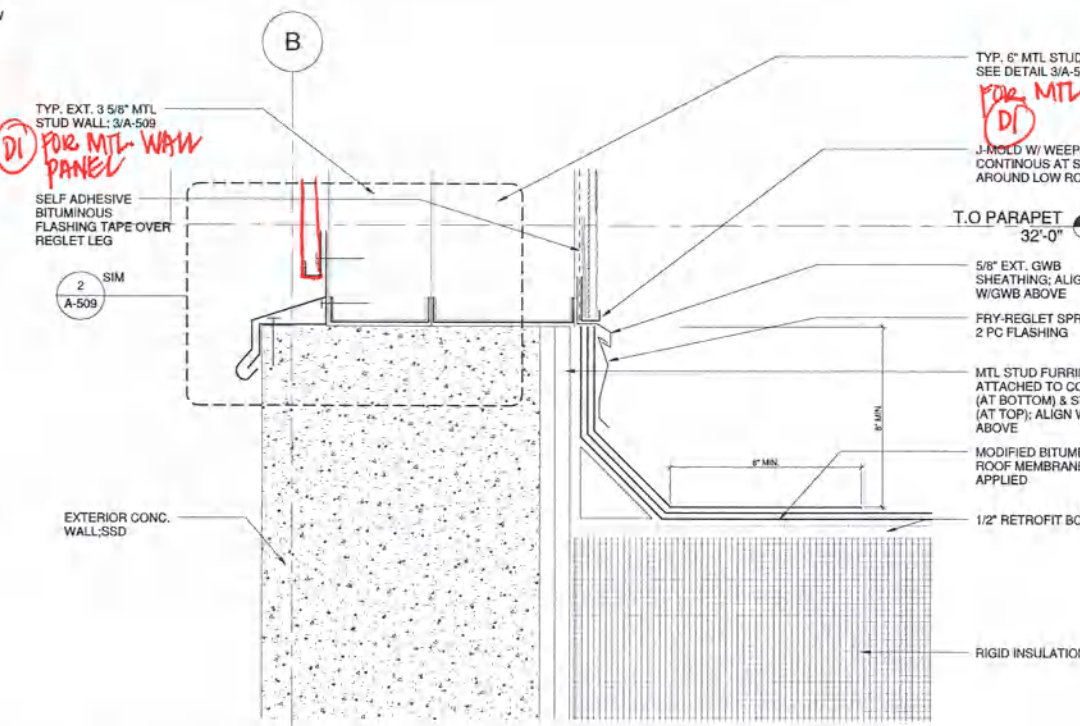



5 EXTERIOR PENTHOUSE ROOF WALL & CURB 3' x 1'-0"

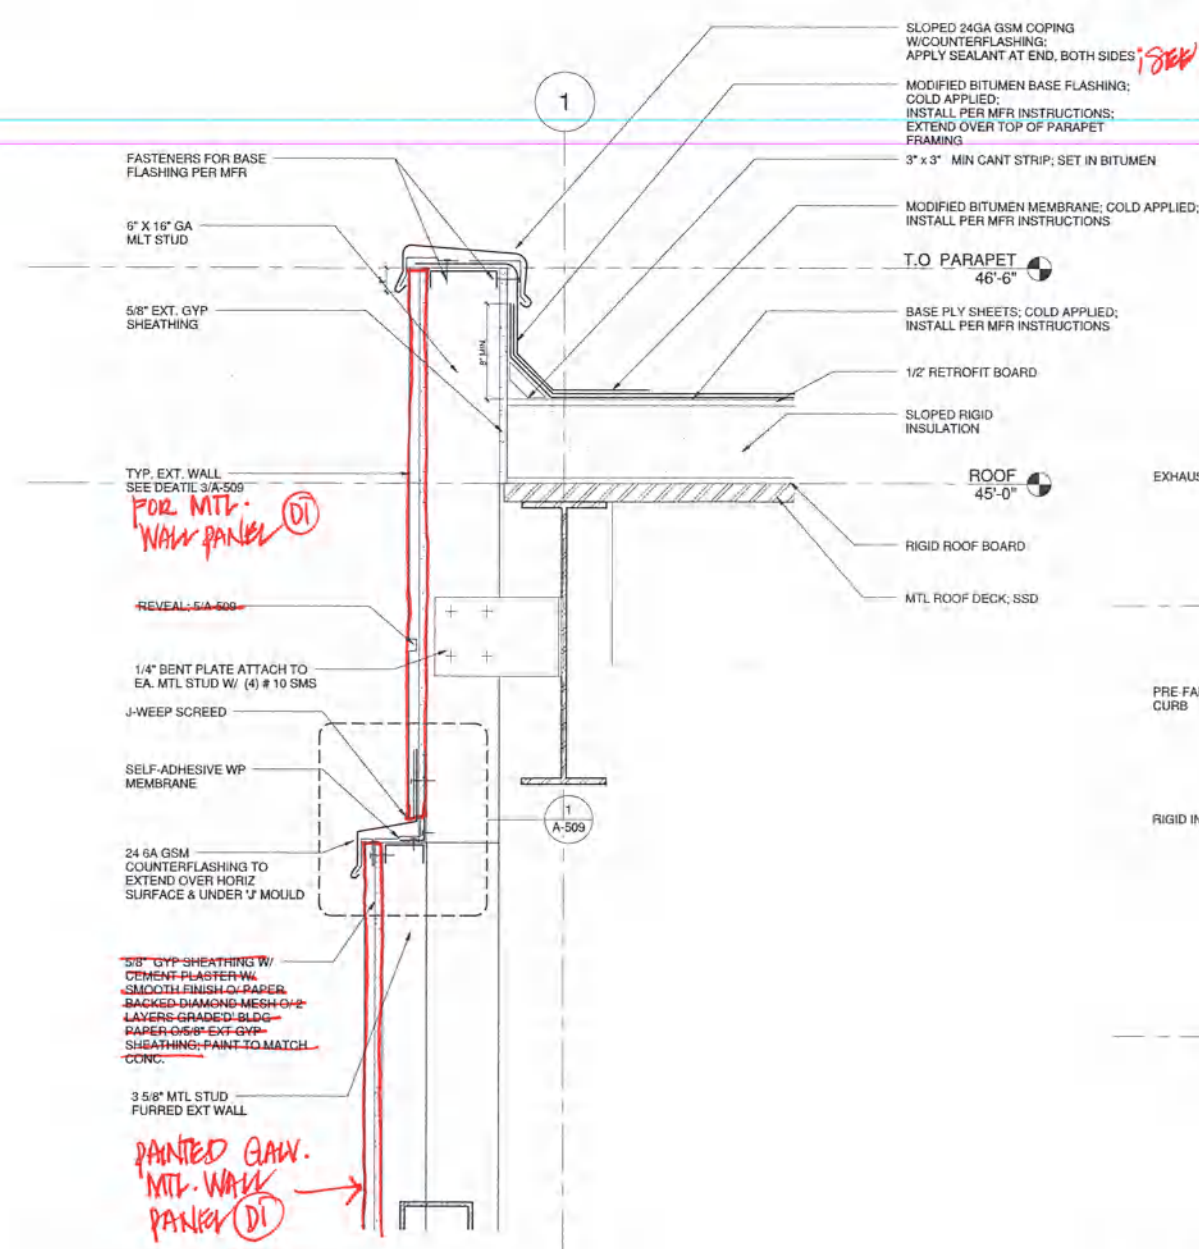

1 WALL SECTION @ RIDGE 1 1/2' x 1'-0"

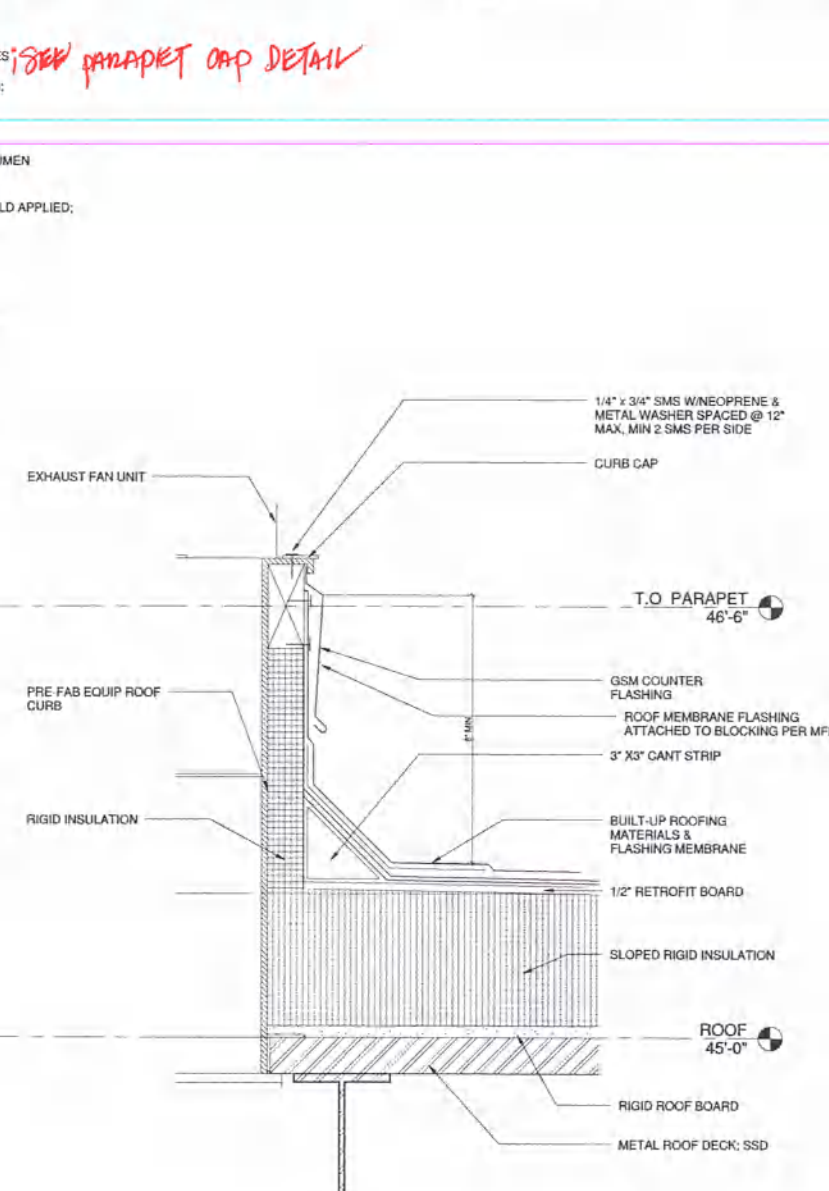

2 SECTION @ EXHAUST FAN UNIT CURB 3' x 1'-0"

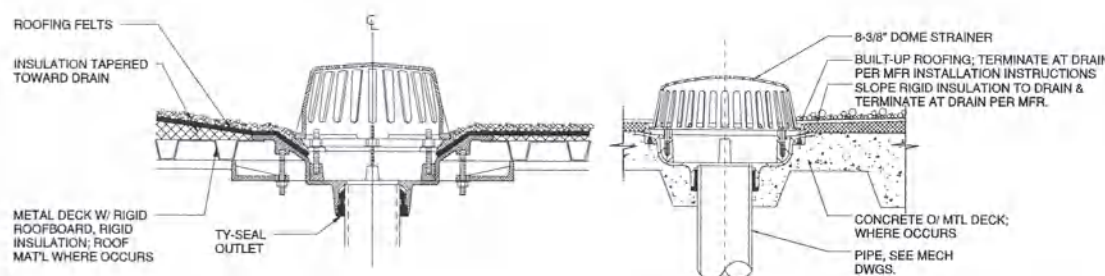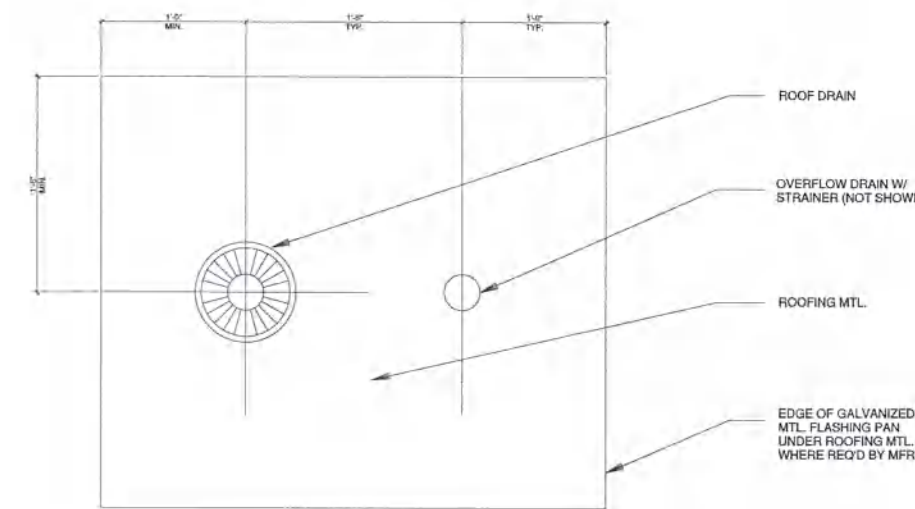

NOTE: OVERFLOW ROOF DRAIN RIM TO BE 2" ABOVE ROOF DRAIN, PER PLUMBING DRAWINGS. USE DRAIN RISER ADJUSTABLE ROOF EXTENSION ASSEMBLY.

3 ROOF DRAIN & OVERFLOW NTS

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LANDSCAPE Merril Morris Partners 240 First Street San Francisco, CA 94111

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CONSULTANT:

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ARCHITECTS/ENGINEERS:

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Drawing Title

ROOF DETAILS

Approved: Project Director

Project Title

VMU Replacement And Expansion Project

Location

San Francisco VA Medical Center 4150 Clement Street, San Francisco, CA 94121

Date

04 March 2011

Checked by

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Drawn

GB

Project Number

662-10-608

Building Number

17

Drawing Number


A-503

Office of Construction and Facilities Management

Department of Veterans Affairs

Contract Documents Submission (CD3 - 100%)

FULLY SPRINKLERED

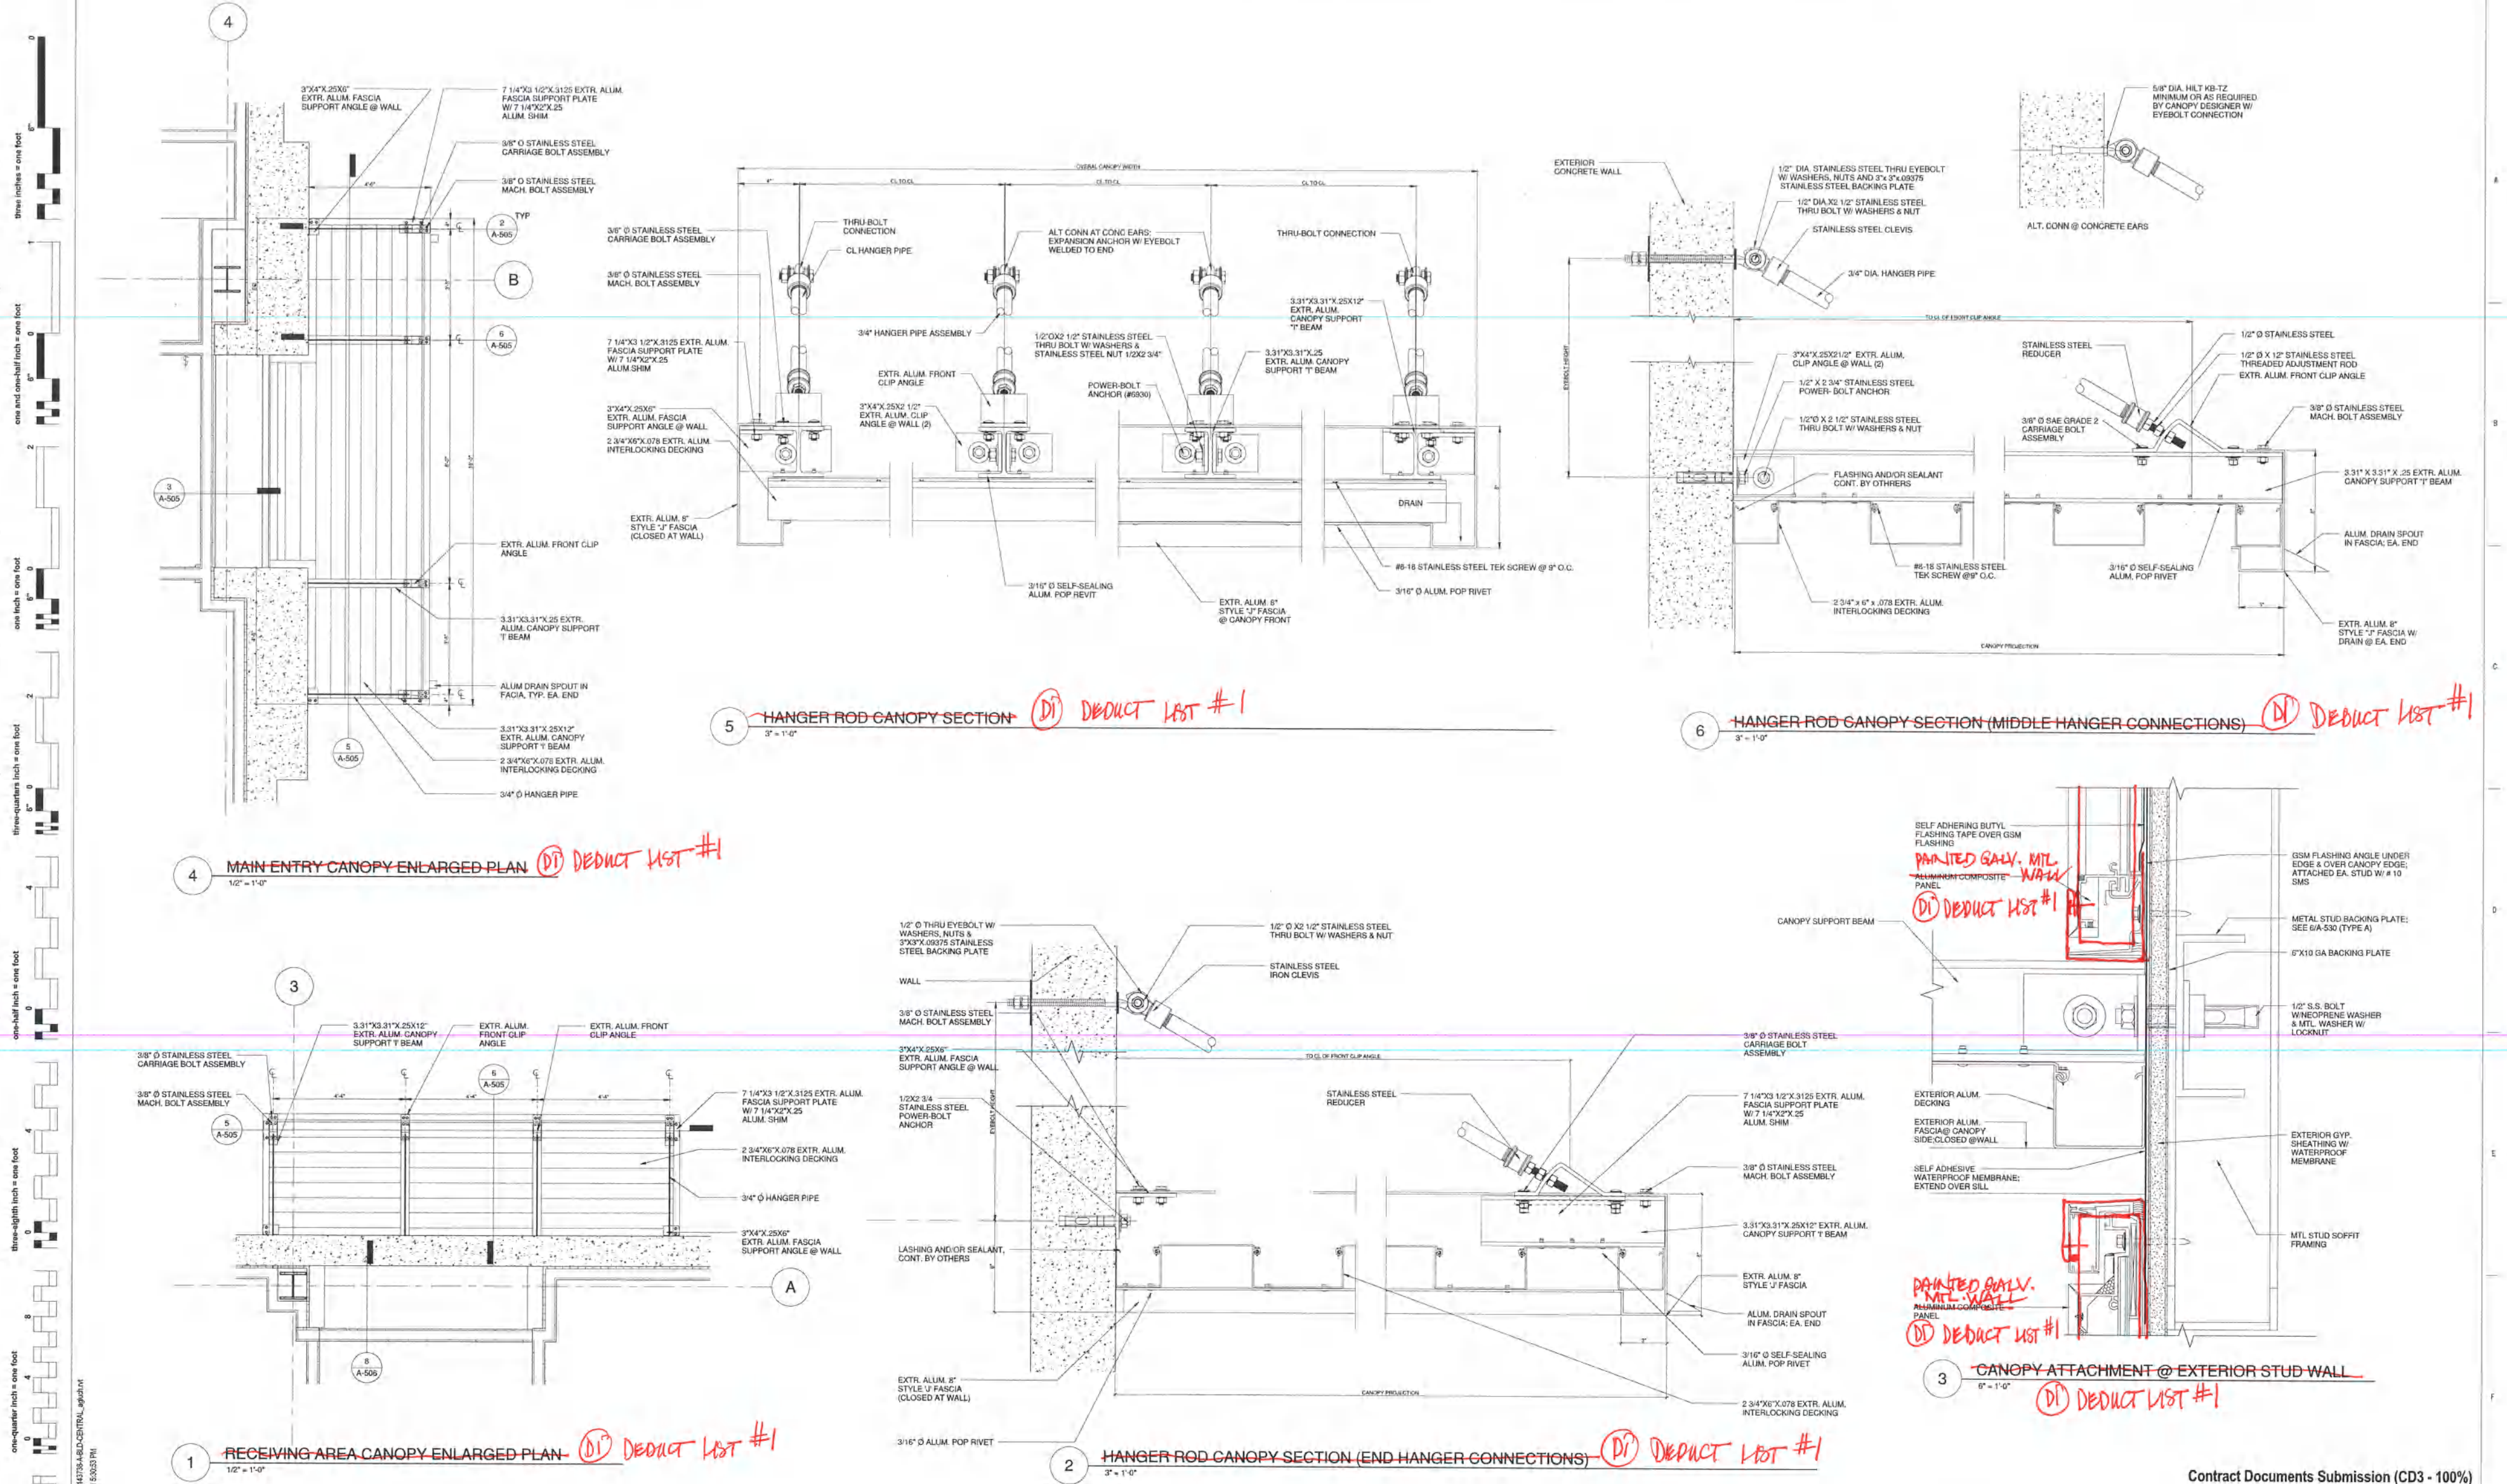

4 MAIN ENTRY CANOPY ENLARGED PLAN (D) DEDUCT LIST #1

5 HANGER ROD CANOPY SECTION (D) DEDUCT LIST #1

6 HANGER ROD CANOPY SECTION (MIDDLE HANGER CONNECTIONS) (D) DEDUCT LIST #1

1 RECEIVING AREA CANOPY ENLARGED PLAN (D) DEDUCT LIST #1

2 HANGER ROD CANOPY SECTION (END HANGER CONNECTIONS) (D) DEDUCT LIST #1

3 CANOPY ATTACHMENT @ EXTERIOR STUD WALL (D) DEDUCT LIST #1

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Drawing Title
CANOPY DETAILS

Approved: Project Director

Project Title
VMU Replacement And Expansion Project

Location
San Francisco VA Medical Center
4150 Clement Street, San Francisco, CA 94121

Date
04 March 2011

Checked by
TQ

Drawn
GB

Contract Documents Submission (CD3 - 100%)
FULLY SPRINKLERED




Project Number
662-10-608

Building Number
17

Drawing Number
A-505

Office of Construction and Facilities Management
Department of Veterans Affairs

Scale bars for various drawing sections: 1/2" = 1'-0", 1/4" = 1'-0", 3/8" = 1'-0", 1/8" = 1'-0", 1/16" = 1'-0", 1/32" = 1'-0", 1/64" = 1'-0", 1/128" = 1'-0", 1/256" = 1'-0", 1/512" = 1'-0", 1/1024" = 1'-0", 1/2048" = 1'-0", 1/4096" = 1'-0", 1/8192" = 1'-0", 1/16384" = 1'-0", 1/32768" = 1'-0", 1/65536" = 1'-0", 1/131072" = 1'-0", 1/262144" = 1'-0", 1/524288" = 1'-0", 1/1048576" = 1'-0", 1/2097152" = 1'-0", 1/4194304" = 1'-0", 1/8388608" = 1'-0", 1/16777216" = 1'-0", 1/33554432" = 1'-0", 1/67108864" = 1'-0", 1/134217728" = 1'-0", 1/268435456" = 1'-0", 1/536870912" = 1'-0", 1/1073741824" = 1'-0", 1/2147483648" = 1'-0", 1/4294967296" = 1'-0", 1/8589934592" = 1'-0", 1/17179869184" = 1'-0", 1/34359738368" = 1'-0", 1/68719476736" = 1'-0", 1/137438953472" = 1'-0", 1/274877906944" = 1'-0", 1/549755813888" = 1'-0", 1/1099511627776" = 1'-0", 1/2199023255552" = 1'-0", 1/4398046511104" = 1'-0", 1/8796093022208" = 1'-0", 1/17592186044416" = 1'-0", 1/35184372088832" = 1'-0", 1/70368744177664" = 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CONSULTANTS:			
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		The Fire Consultants Inc. 1276 Duran Walnut Creek, CA 94596	
		COST ESTIMATING	
		Dock Landings 341 Samsom Street, Ste. 10 San Francisco, CA 94104	

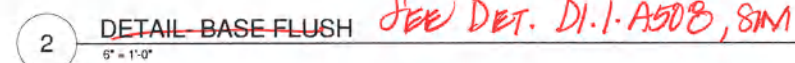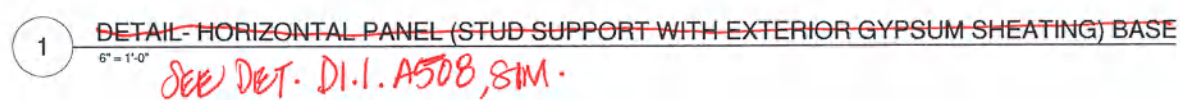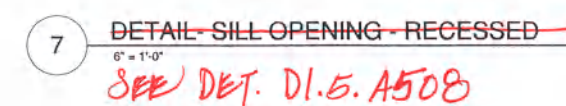ARCHITECTS/ENGINEERS:


HDR

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PH 415-546-4200 FAX 415-546-4202

Professional Seal of Steven J. Riquias, State of California, No. C-26508, dated 8/31/2011.

Project Title <h1 style="text-align: center;">VMU Replacement And Expansion Project</h1>		
Location San Francisco VA Medical Center 4150 Clement Street, San Francisco, CA 94121		
Date 04 March 2011	Checked by TQ	Drawn GB


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Management

 Department of
Veterans Affairs


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FULLY SPRINKLERED


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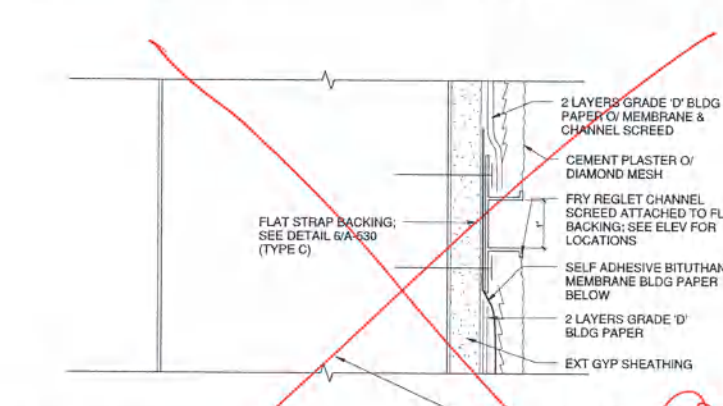
DEDUCT LIST KEYNOTES.
DI DEDUCT LIST #1



DI PS-12 W/AV PANEL
PAINTED GALV.
MTL. PANEL
ALUM. COMPOSITE PANEL

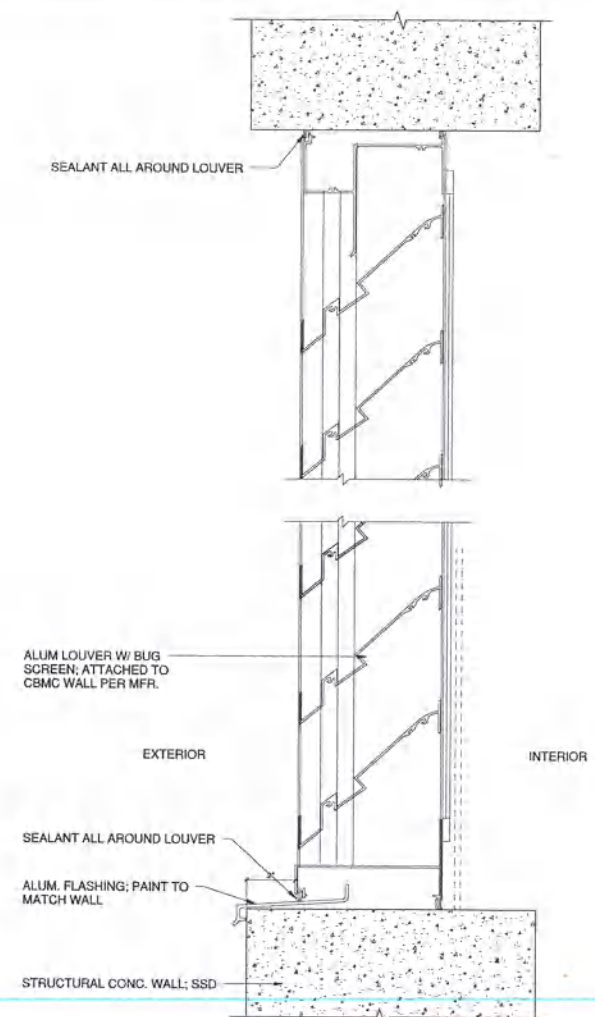

9 LOUVER SILL & HEAD @ EXTERIOR CONCRETE WALL
3" x 1'-0"

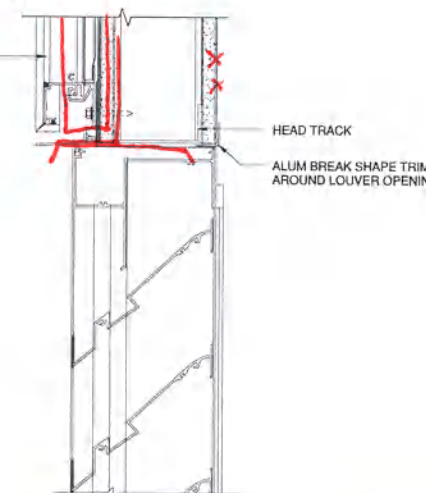

5 HORIZONTAL CHANNEL REVEAL
6" x 1'-0"




6 LOUVER JAMB @ PENTHOUSE EXTERIOR WALL
3" x 1'-0"



DI PS-12 W/AV PANEL
PAINTED GALV.
MTL. PANEL
ALUM. COMPOSITE PANEL

DI FASTENERS W/ NEOPRENE WASHER + BUTYL SEALANT @ BOTTOM FLASHING & PANEL


DI PS-12 W/AV PANEL

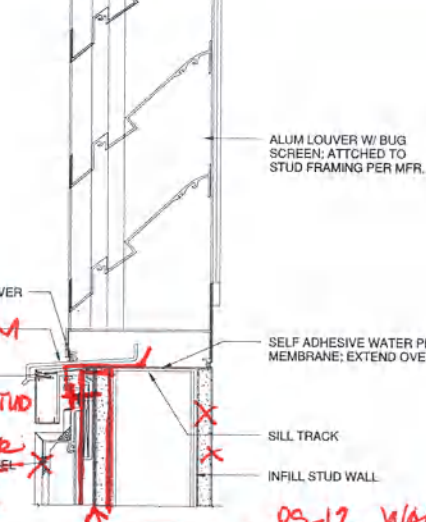


7 LOUVER @ EXTERIOR STUD WALL
3" x 1'-0"




8 LOUVER SILL & HEAD @ PENTHOUSE EXTERIOR WALL
3" x 1'-0"

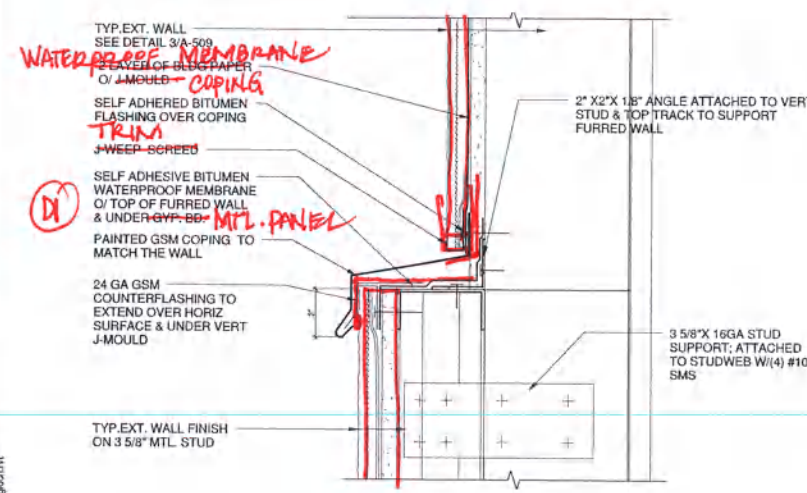


1 EXTERIOR FURRED WALL & FLASHING
3" x 1'-0"

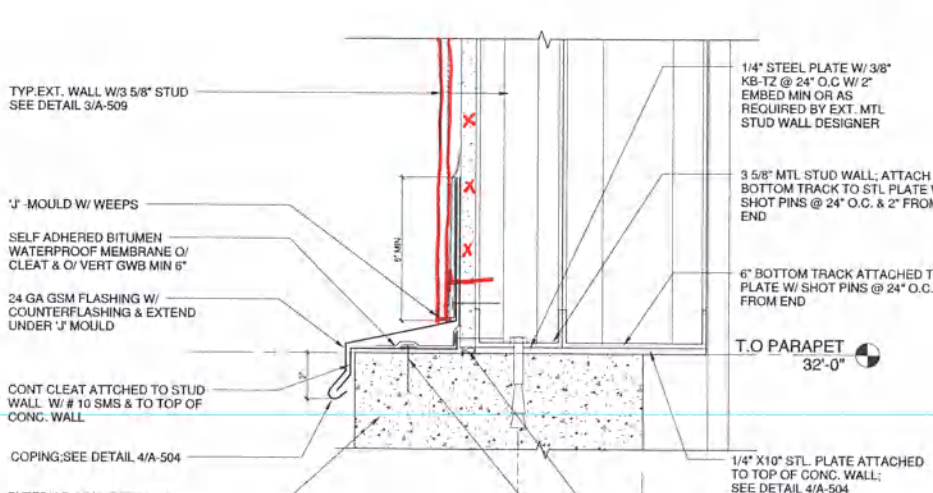

2 EXTERIOR PENTHOUSE STUD-WALL BASE
3" x 1'-0"

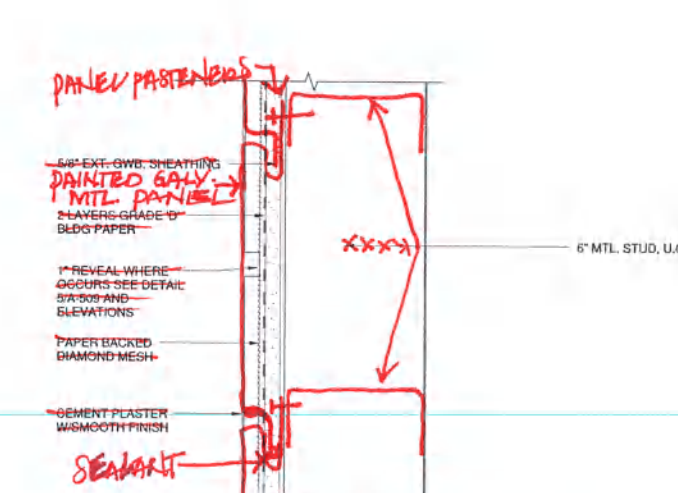

3 TYP. EXTERIOR CEMENT PLASTER WALL - VERTICAL DI
3" x 1'-0"

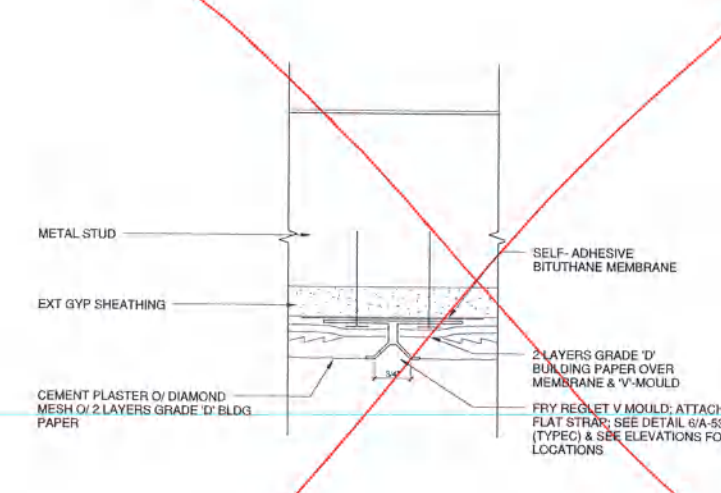

4 VERTICAL V MOLD REVEAL
6" x 1'-0"

Contract Documents Submission (CD3 - 100%)
FULLY SPRINKLERED

CONSULTANTS: ARCHITECTURE: HDR Architecture, Inc. 560 Mission Street, Suite 900 San Francisco, CA 94105 MECHANICAL/ELECTRICAL/PLUMBING: HDR Architecture, Inc. 560 Mission Street, Suite 900 San Francisco, CA 94105 STRUCTURAL: HDR Architecture, Inc. 560 Mission Street, Suite 900 San Francisco, CA 94105 CIVIL/SURVEYOR: HDR Architecture, Inc. 560 Mission Street, Suite 900 San Francisco, CA 94105 LANDSCAPE: HDR Architecture, Inc. 560 Mission Street, Suite 900 San Francisco, CA 94105 FIRE PROTECTION: HDR Architecture, Inc. 560 Mission Street, Suite 900 San Francisco, CA 94105 GEOTECHNICAL/ENVIRONMENTAL SERVICES: HDR Architecture, Inc. 560 Mission Street, Suite 900 San Francisco, CA 94105 HISTORICAL ARCHITECTURE: HDR Architecture, Inc. 560 Mission Street, Suite 900 San Francisco, CA 94105 COST ESTIMATING: HDR Architecture, Inc. 560 Mission Street, Suite 900 San Francisco, CA 94105		CONSULTANT: ARCHITECTS/ENGINEERS: HDR HDR Architecture, Inc. 560 Mission Street, Suite 900 San Francisco, CA 94105 PH: 415-566-4200 FAX: 415-566-4202		ARCHITECTS/ENGINEERS: HDR HDR Architecture, Inc. 560 Mission Street, Suite 900 San Francisco, CA 94105 PH: 415-566-4200 FAX: 415-566-4202		Office of Construction and Facilities Management Department of Veterans Affairs	
Project Title: VMU Replacement And Expansion Project		Location: San Francisco VA Medical Center 4150 Clement Street, San Francisco, CA 94121		Project Number: 662-10-608 Building Number: 17 Drawing Number: A-509			
Date: 04 March 2011		Checked by: TQ		Drawn by: GB			




IDENTIFICATION		DOOR AND FRAME SCHEDULE																	HARDWARE		NOTES	
		DIMENSIONS			PANEL			FRAME			FRAME DETAIL											
		DOOR NO.	W	H	T	TYPE	MATERIAL	FINISH	GLAZING MATL	TYPE	MATERIAL	FINISH	HEAD	JAMB	FIRE RATING	STC RATING	GROUP	ELECTRICAL				
G02	3'-0"	7'-6"	1'-3/4"	G	STEEL	PT-9/ PT-7			1	STEEL	PT-9/ PT-7	7/4-502	2/4-502	NR	45	6G	CARD READER	FINISHES INTERIOR/ EXTERIOR; DETAIL 2 & 3				
G03	3'-0"	7'-6"	1'-3/4"	F	FIBERGLASS	—	TEMPERED CLEAR GLASS		2	STAINLESS STEEL	SATIN BRUSHED	3/4-502	1/4-502	NR	45	10A	PUSH PLATES	DETAIL 2 & 3				
G04	3'-0"	7'-6"	1'-3/4"	F	FIBERGLASS	—	TEMPERED CLEAR GLASS		2	STAINLESS STEEL	SATIN BRUSHED	3/4-502	1/4-502	NR	45	10A	PUSH PLATES	DETAIL 2 & 3				
G05	3'-0"	7'-6"	1'-3/4"	F	STEEL	PT-9	TEMPERED CLEAR GLASS		2	STEEL	PT-9	3/4-502	1/4-502	SS	45	10	PUSH PLATES	DETAIL 2 & 3				
G06	3'-0"	7'-6"	1'-3/4"	G	STEEL	PT-9	—		1	STEEL	PT-9	3/4-502	1/4-502	NR	45	4B	—	DETAIL 2 & 3				
G07A	3'-0"	7'-6"	1'-3/4"	A	STEEL	PT-9/ PT-7			3	STEEL	PT-9/ PT-7	3/4-502	1/4-502	NR	45	SH-9	CARD READER	DETAIL 2: FINISHES INTERIOR/ EXTERIOR				
G07B	3'-0"	7'-6"	1'-3/4"	F	STEEL	PT-9	TEMPERED CLEAR GLASS		2	STEEL	PT-9	3/4-502	1/4-502	NR	45	6E	PUSH PLATES	DETAIL 2 & 3				
G08	3'-0"	7'-6"	1'-3/4"	G	STEEL	PT-9	—		1	STEEL	PT-9	3/4-502	1/4-502	NR	45	4C	—	DETAIL 2 & 3				
G09	3'-0"	7'-6"	1'-3/4"	H	STEEL	PT-9/ PT-7			2	STEEL	PT-9/ PT-7	3/4-502	1/4-502	NR	45	6B	CARD READER	FINISHES INTERIOR/ EXTERIOR				
G10	3'-0"	7'-6"	1'-3/4"	F	STEEL	PT-9	TEMPERED CLEAR GLASS		2	STAINLESS STEEL	SATIN BRUSHED	3/4-502	1/4-502	NR	45	10C	—	DETAIL 2 & 3				
G11	3'-0"	7'-6"	1'-3/4"	G	STEEL	PT-9	—		1	STEEL	PT-9	3/4-502	1/4-502	NR	45	4B	—	DETAIL 2 & 3				
G12	3'-0"	7'-6"	1'-3/4"	D	STEEL	PT-9	TEMPERED CLEAR GLASS		1	STEEL	PT-9	3/4-502	1/4-502	NR	45	3E	CARD READER	DETAIL 2				
G14	2'-8"	7'-6"	1'-3/4"	G	STEEL	PT-9	—		1	STEEL	PT-9	3/4-502	1/4-502	NR	45	3E	CARD READER	DETAIL 2 & 3				
G15	3'-6"	7'-6"	1'-3/4"	D	STEEL	PT-9	TEMPERED CLEAR GLASS		1	STAINLESS STEEL	SATIN BRUSHED	3/4-502	1/4-502	NR	45	1F	—	DETAIL 2 & 3				
G16	3'-0"	7'-6"	1'-3/4"	D	STEEL	PT-9	TEMPERED CLEAR GLASS		1	STAINLESS STEEL	SATIN BRUSHED	3/4-502	1/4-502	NR	45	SH-3	CARD READER	DETAIL 2 & 3				
G17	3'-0"	7'-6"	1'-3/4"	B	ALUMINUM	ANODIZED	INSULATING GLASS, SEU LOW-E TEMPERED AND CLEAR		2	ALUMINUM	ANODIZED	6/4-501(SIM)	3/4-501(SIM)	NR	45	SH-9	CARD READER	DETAIL 2 & 3				
G18	3'-8"	7'-6"	1'-3/4"	G	STEEL	PT-9/ PT-7			1	STEEL	PT-9/ PT-7	7/4-502	1/4-502	NR	45	6G	CARD READER	FINISHES INTERIOR/ EXTERIOR				
G20A	3'-0"	7'-6"	1'-3/4"	E	STEEL	PT-9	FIRE RESISTANT CLEAR WIRE GLASS		1	STAINLESS STEEL	SATIN BRUSHED	3/4-502	1/4-502	60	45	1A	—	DETAIL 2				
G20B	3'-0"	7'-6"	1'-3/4"	E	ALUMINUM	ANODIZED	INSULATING GLASS, SEU LOW-E TEMPERED AND CLEAR		6	ALUMINUM	ANODIZED	6/4-501(SIM)	3/4-501(SIM)	NR	45	E4	—	DETAIL 2				
G21	3'-0"	7'-6"	1'-3/4"	G	STEEL	PT-9	—		1	STEEL	PT-9	3/4-502	1/4-502	NR	45	6D	—	DETAIL 2 & 3				
G23	3'-0"	7'-6"	1'-3/4"	E	STEEL	PT-9	—		1	STEEL	PT-9	3/4-502	1/4-502	NR	45	SH-3	—	DETAIL 2				
G24	3'-0"	7'-6"	1'-3/4"	G	STEEL	PT-9	FIRE RESISTANT CLEAR WIRE GLASS		5	STEEL	PT-9	3/4-502	1/4-502	NR	45	1C	CARD READER	DETAIL 2				
101A	3'-6"	7'-6"	1'-3/4"	C	STEEL	PT-9	TEMPERED CLEAR GLASS W/ RED SCREEN		1	STAINLESS STEEL	SATIN BRUSHED	3/4-502	1/4-502	NR	45	4	—	DETAIL 2 & 3				
101B	3'-6"	7'-6"	1'-3/4"	C	STEEL	PT-9	TEMPERED CLEAR GLASS W/ RED SCREEN		1	STAINLESS STEEL	SATIN BRUSHED	3/4-502	1/4-502	NR	45	4	—	DETAIL 2 & 3				
102	3'-6"	7'-6"	1'-3/4"	C	STEEL	PT-9	TEMPERED CLEAR GLASS W/ RED SCREEN		1	STAINLESS STEEL	SATIN BRUSHED	3/4-502	1/4-502	NR	45	4	—	DETAIL 2 & 3				
102A	3'-6"	7'-6"	1'-3/4"	C	STEEL	PT-9	TEMPERED CLEAR GLASS W/ RED SCREEN		1	STAINLESS STEEL	SATIN BRUSHED	3/4-502	1/4-502	NR	45	4	—	DETAIL 2 & 3				
102B	3'-6"	7'-6"	1'-3/4"	C	STEEL	PT-9	TEMPERED CLEAR GLASS W/ RED SCREEN		1	STAINLESS STEEL	SATIN BRUSHED	3/4-502	1/4-502	NR	45	4	—	DETAIL 2 & 3				
103	3'-6"	7'-6"	1'-3/4"	C	STEEL	PT-9	TEMPERED CLEAR GLASS W/ RED SCREEN		1	STAINLESS STEEL	SATIN BRUSHED	3/4-502	1/4-502	NR	45	4	—	DETAIL 2 & 3				
104	3'-6"	7'-6"	1'-3/4"	C	STEEL	PT-9	TEMPERED CLEAR GLASS W/ RED SCREEN		1	STAINLESS STEEL	SATIN BRUSHED	3/4-502	1/4-502	NR	45	4	—	DETAIL 2 & 3				
105	3'-6"	7'-6"	1'-3/4"	C	STEEL	PT-9	TEMPERED CLEAR GLASS W/ RED SCREEN		1	STAINLESS STEEL	SATIN BRUSHED	3/4-502	1/4-502	NR	45	4	—	DETAIL 2 & 3				
106	3'-6"	7'-6"	1'-3/4"	C	STEEL	PT-9	TEMPERED CLEAR GLASS W/ RED SCREEN		1	STAINLESS STEEL	SATIN BRUSHED	3/4-502	1/4-502	NR	45	SH-3	CARD READER	DETAIL 2 & 3				
107	3'-6"	7'-6"	1'-3/4"	C	STEEL	PT-9	TEMPERED CLEAR GLASS W/ RED SCREEN		1	STAINLESS STEEL	SATIN BRUSHED	3/4-502	1/4-502	NR	45	SH-3	CARD READER	DETAIL 2 & 3				
108	3'-6"	7'-6"	1'-3/4"	C	STEEL	PT-9	TEMPERED CLEAR GLASS W/ RED SCREEN		1	STAINLESS STEEL	SATIN BRUSHED	3/4-502	1/4-502	NR	45	SH-3	CARD READER	DETAIL 2 & 3				
109	3'-6"	7'-6"	1'-3/4"	C	STEEL	PT-9	TEMPERED CLEAR GLASS W/ RED SCREEN		1	STAINLESS STEEL	SATIN BRUSHED	3/4-502	1/4-502	NR	45	SH-3	CARD READER	DETAIL 2 & 3				
110	3'-6"	7'-6"	1'-3/4"	C	STEEL	PT-9	TEMPERED CLEAR GLASS W/ RED SCREEN		1	STAINLESS STEEL	SATIN BRUSHED	3/4-502	1/4-502	NR	45	SH-3	CARD READER	DETAIL 2 & 3				
111	3'-6"	7'-6"	1'-3/4"	C	STEEL	PT-9	TEMPERED CLEAR GLASS W/ RED SCREEN		1	STAINLESS STEEL	SATIN BRUSHED	3/4-502	1/4-502	NR	45	SH-3	CARD READER	DETAIL 2 & 3				
112	3'-6"	7'-6"	1'-3/4"	C	STEEL	PT-9	TEMPERED CLEAR GLASS W/ RED SCREEN		1	STAINLESS STEEL	SATIN BRUSHED	3/4-502	1/4-502	NR	45	SH-3	CARD READER	DETAIL 2 & 3				
113	3'-6"	7'-6"	1'-3/4"	C	STEEL	PT-9	TEMPERED CLEAR GLASS W/ RED SCREEN		1	STAINLESS STEEL	SATIN BRUSHED	3/4-502	1/4-502	NR	45	4	—	DETAIL 2 & 3				
115	3'-6"	7'-6"	1'-3/4"	E	STEEL	PT-9	TEMPERED CLEAR GLASS		4	STAINLESS STEEL	SATIN BRUSHED	3/4-502	1/4-502	NR	45	SH-3	CARD READER	DETAIL 2 & 3				
116	3'-6"	7'-6"	1'-3/4"	C	STEEL	PT-9	TEMPERED CLEAR GLASS		1	STAINLESS STEEL	SATIN BRUSHED	3/4-502	1/4-502	NR	45	SH-3	CARD READER	DETAIL 2 & 3				
118	3'-6"	7'-6"	1'-3/4"	E	STEEL	PT-9	FIRE RESISTANT CLEAR WIRE GLASS		1	STAINLESS STEEL	SATIN BRUSHED	3/4-502	1/4-502	60	45	1A	—	DETAIL 2 & 3				
119	3'-0"	7'-6"	1'-3/4"	G	STEEL	PT-9	FIRE RESISTANT CLEAR WIRE GLASS		5	STAINLESS STEEL	SATIN BRUSHED	3/4-502	1/4-502	NR	45	3E	CARD READER	DETAIL 2 & 3				
121	3'-0"	7'-6"	1'-3/4"	E	STEEL	PT-9	FIRE RESISTANT CLEAR WIRE GLASS		1	STAINLESS STEEL	SATIN BRUSHED	3/4-502	1/4-502	NR	45	1C	—	DETAIL 2 & 3				
122	3'-6"	7'-6"	1'-3/4"	C	STEEL	PT-9	TEMPERED CLEAR GLASS		1	STAINLESS STEEL	SATIN BRUSHED	3/4-502	1/4-502	NR	45	4	—	DETAIL 2 & 3				
P01	3'-0"	7'-6"	1'-3/4"	G	STEEL	PT-9	—		1	STEEL	PT-9	3/4-502	1/4-502	60	45	1C	—	DETAIL 2				
P02	3'-0"	7'-6"	1'-3/4"	H	STEEL	PT-9/ PT-7	—		2	STEEL	PT-9/ PT-7	3/4-502	1/4-502	NR	45	11C	—					
P03	3'-6"	7'-6"	2"	H	STEEL	PT-9	—		1	STEEL	PT-9	3/4-502	1/4-502	NR	45	5G	—					
P04	3'-6"	7'-6"	2"	H	STEEL	PT-9	—		1	STEEL	PT-9	3/4-502	1/4-502	NR	45	5G	—					

LEGEND	
NR	NON-RATED
SS	SMOKE SEALED
60	60 MINUTE FIRE RATED
PT	PAINT - SEE SPECIFICATIONS


D2 D5

DEDUCT VST KEYNOTES.
 D1 DEDUCT LIST #1
 D2 DEDUCT LIST #2
 D5 DEDUCT LIST #5

NOTE: FOR HARDWARE GROUPS SEE SPEC SECTION 087100

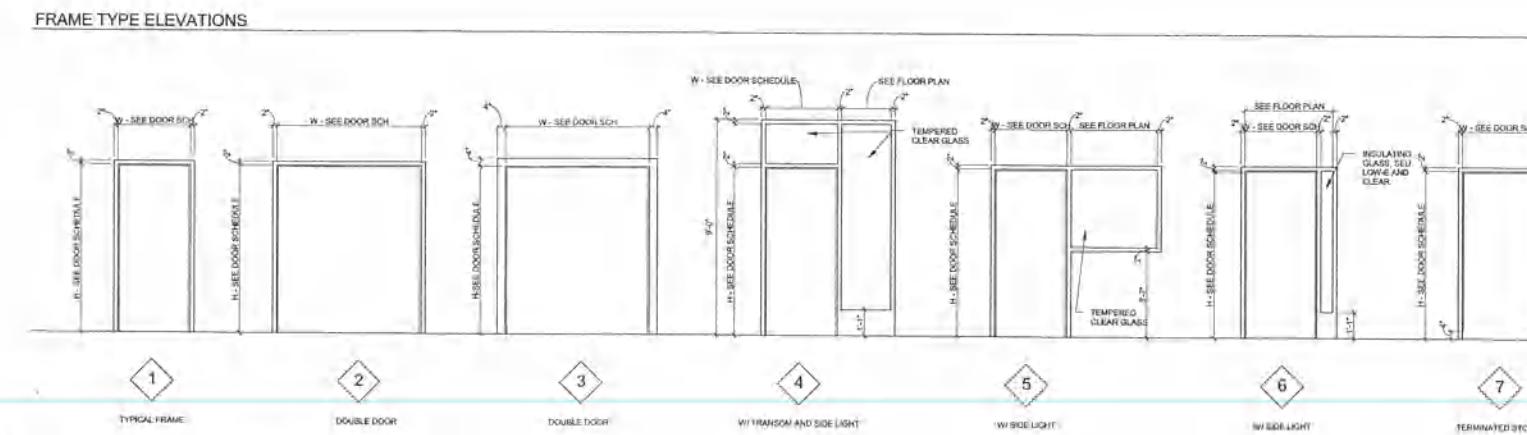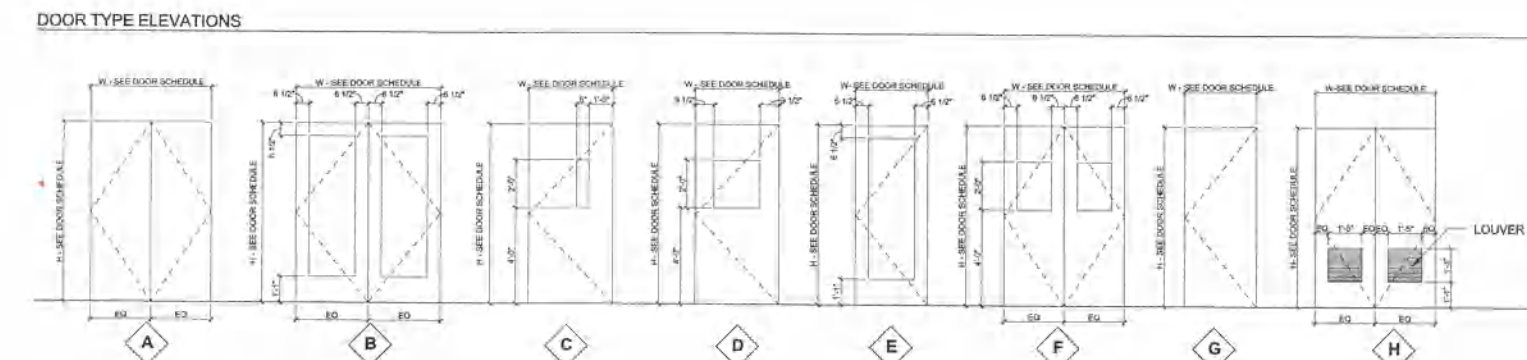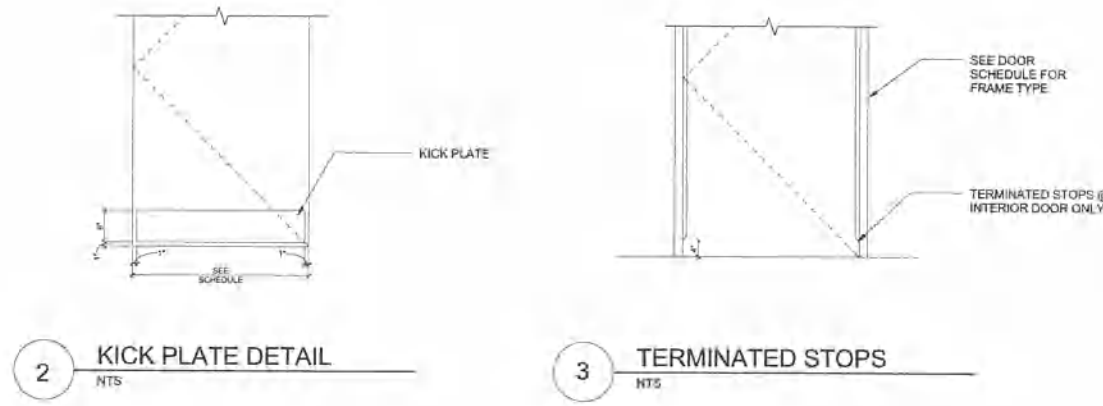

Window Schedule									
TYPE MARK	OPENING		SILL HEIGHT	WINDOW TYPE	GLASS TYPE	FRAME MATERIAL	FRAME FINISH	COMMENTS	
	WIDTH	HEIGHT							
A	4'-0"	5'-2"	3'-8"	FIXED WITH MULLION	INSULATING GLASS, SEU LOW-E AND CLEAR	ALUMINUM	ANODIZED		
B	2'-2"	5'-6"		FIXED	INSULATING GLASS, SEU LOW-E AND CLEAR	ALUMINUM	ANODIZED		
C	7'-0"	9'-0"	0"	FIXED WITH MULLION	INSULATING GLASS, SEU LOW-E AND CLEAR	ALUMINUM	ANODIZED		
D	4'-0"	4'-2"	3'-6"	FIXED WITH MULLION	INSULATING GLASS, SEU LOW-E AND CLEAR	ALUMINUM	ANODIZED	WINDOW SHADE (OFOI)	
E	2'-9"	4'-2"	3'-6"	FIXED WITH MULLION	INSULATING GLASS, SEU LOW-E AND CLEAR	ALUMINUM	ANODIZED	WINDOW SHADE (OFOI)	
F	5'-2"	5'-2"	3'-8"	FIXED WITH MULLION	INSULATING GLASS, SEU LOW-E AND CLEAR	ALUMINUM	ANODIZED		
G	2'-9"	2'-9"		FIXED	INSULATING GLASS, SEU LOW-E AND CLEAR	ALUMINUM	ANODIZED		
H	5'-11 5/16"	3'-11"	3'-7"	FIXED	TEMPERED FROSTED GLASS	STEEL	PT-9	ADJUST WIDTH TO ALIGNMENT INDICATED IN FLOOR PLAN	
I	2'-9"	7'-8"	0"		INSULATING GLASS, SEU LOW-E TEMPERED AND CLEAR	ALUMINUM	ANODIZED		
J	4'-0"	2'-2"	5'-6"	FIXED	INSULATING GLASS, SEU LOW-E OBSCURE GLAZING ASSEMBLY (LAMINATED)	ALUMINUM	ANODIZED		

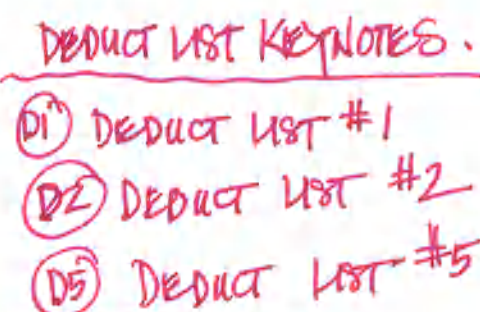

FINISH CODE		MATERIAL	MANUFACTURER	MANUFACTURER NO.	SIZE	STYLE	COLOR	Finish	NOTES
ACT	ACOUSTIC CEILING TILE		ARMSTRONG		24"X48"	ULTIMA	WHITE (STANDARD)		
CB	INTEGRAL COVED BASE								
CPT	CARPET								
CT-1	CERAMIC PORCELAIN TILE	SHAW CONTRACT GROUP	55579	24"X24"	CATALYST TILE	#64781, DAPPLE			MONOLITHIC (2) L. INSTALLATION METHOD
CT-2	CERAMIC PORCELAIN TILE	CROSSVILLE		6"X12"	RETRO ACTIVE PORCELAIN STONE	#210, SEABREEZE, LIP (UNPOLISHED)			TYPICAL WALL TILE, U.O.N.
CT-3	CERAMIC PORCELAIN TILE	CROSSVILLE		12"X12"	RETRO ACTIVE PORCELAIN STONE	#210, SEABREEZE, PD (POLISHED)			ACCENT WALL TILE
CT-3	CERAMIC PORCELAIN TILE	CROSSVILLE		12"X12"	VISTA AMERICANA	# AV182, FOOTHILLS			TYPICAL U.O.N. @ SHOWER LOCKER ROOM FLOORING/ BASE
EPV	EPOXY RESINUS FLOORING	STONCLOAD GR							
FR-HBES	FIBERGLASS REINFORCED HIGH BUILD EPOXY SYSTEM						CUSTOM COLOR 95% WHITE W/ 1 COLOR FLECK	WITH TECH TOP EF	CAGE WASH AREAS
GL	GLASS						TO MATCH BENJAMIN MOORE OC-6 FEATHER DOWN (PT-1)		
GWB-1	TYPE X GYPSUM WALL BOARD								
GWB-2	IMPACT RESISTANT GYPSUM WALL BOARD	USG			FIBEROCK AR			LEVEL 4 WITH PT	LEVEL 2 WITH WP
GWB-3	ABUSE RESISTANT GYPSUM WALL BOARD	USG			FIBEROCK VH			LEVEL 4 WITH PT	LEVEL 4 WITH WP
GWB-4	ABUSE & WATER RESISTANT GYPSUM WALL BOARD	USG			FIBEROCK AQUA TOUGH			LEVEL 4 WITH PT	LEVEL 2 WITH CT
								LEVEL 3 WITH HBES	LEVEL 2 WITH WP
NR-HBES	NON- REINFORCED HIGH BUILD EPOXY SYSTEM								
PT-1	LATEX ACRYLIC PAINT	BENJAMIN MOORE					TO MATCH BENJAMIN MOORE OC-6 FEATHER DOWN (PT-1)		
PT-2	EPOXY PAINT						OC-6 FEATHER DOWN		TYPICAL, U.O.N.
PT-3	LATEX ACRYLIC PAINT	BENJAMIN MOORE					TO MATCH BENJAMIN MOORE OC-6 FEATHER DOWN (PT-1)		
PT-4	LATEX ACRYLIC PAINT	BENJAMIN MOORE					HC-146, WEDGEWOOD GRAY		OFFICE WALL ACCENT
PT-5	LATEX ACRYLIC PAINT	BENJAMIN MOORE					HC-143, WYTHE BLUE		STAIR WALL ACCENT
RB	RESILIENT RUBBER BASE	JOHNSONITE		4" HIGH			HC-136, WATERBURY GREEN		STAIR HANDRAIL COLOR
RT-1	RESILIENT RUBBER TILE	NORA	ARTICLE 1880	39.37"X39.37"	NORAMENT GRANO		55 SILVER GRAY WG		TYPICAL, U.O.N.
RT-2	RESILIENT RUBBER TILE	NORA	ARTICLE 1880	39.37"X39.37"	NORAMENT GRANO		#4875 DALMATIAN DASPERS		
SC	SEALED CONCRETE						#4873 LONDON BLUE TOPAZ		SEE FINISH PLANS FOR ACCENTS
UR	URETHANE RESINUS FLOORING	STONCLOAD UR							
WCT	WASHABLE CEILING TILE	ARMSTRONG		24"X48"	OPTIMA HEALTH ZONE	CUSTOM COLOR		WITH STANDARD UT SEALER	
WCT	WALL PROTECTION PANEL SYSTEM	ALTHO			WHITEROCK			PEBBLETE TEXTURE	CAGE WASH PITS
WCT	WALL PROTECTION PANEL SYSTEM	ACROVYN					#517 TETON WHITE		@ JANITORIAL CLOSET

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No.	Description	Cash

CONSULTANTS:

ARCHITECTURE/
INTERIOR DESIGN
LABORATORY PLANNING/
ENVIRONMENTAL ASSESSMENT

HDR Architecture, Inc.
560 Mission Street
Suite 900
San Francisco, CA 94105

HDR Architecture, Inc.
560 Mission Street
Suite 900
San Francisco, CA 94105

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560 Mission Street
Suite 900
San Francisco, CA 94105

**GEOTECHNICAL/
ENVIRONMENTAL SERVICE**

**HISTORICAL
ARCHITECTURE**

COST ESTIMATING:

1

F

D

R

1/31/2011

Approved: P

Director

	Location

San Francisco VA Medical Center
50 Clement Street

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San Francisco, CA

17	Drawing n
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Contract Documents Submission (CD3 - 100%)

FULLY SPRINKLERED

Project Number	015-1
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662-10-608

17 Construction and Facilities

Drawing number	and Facilities Management
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21	A-630	Management
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 Department of
Veterans Affairs

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